


- REFLECTED CEILING PLAN LEGEND**
- FULL HEIGHT METAL STUD @ 16" O.C. U.N.O. WITH SOUND BATT. INSULATION AND FINISHES FULL HEIGHT FROM FINISH FLOOR TO DECK ABOVE. REFER TO DETAIL 6, 7 & 8/AS906.
 - PARTIAL HEIGHT METAL STUD @ 16" O.C. U.N.O. WITH SOUND BATT. INSULATION AND FINISHES FROM FINISH FLOOR TO 2" ABOVE FINISH CEILING. REFER TO DETAIL 5/AS906.
 - (E) METAL STUD WALL WITH SOUND BATT. INSULATION. WALL AND FINISHES FULL HEIGHT FROM FINISH FLOOR TO DECK ABOVE. REPLACE FINISHES WHERE NOTED.
 - (E) METAL STUD WALL WITH THERMAL INSULATION. WALL AND FINISHES FULL HEIGHT FROM FINISH FLOOR TO DECK ABOVE. REPLACE FINISHES WHERE NOTED.
 - (E) FULL HEIGHT STRUCTURAL CONCRETE WALL.
 - (E) METAL STUD WALL WITH SOUND BATT. INSULATION. WALL AND FINISHES PARTIAL HEIGHT. REPLACE FINISHES WHERE NOTED.
 - 1 HR FIRE BARRIER. WALL AND FINISHES FULL HEIGHT FROM FLOOR TO DECK ABOVE.
 - (E) 2 HR FIRE BARRIER. WALL AND FINISHES FULL HEIGHT FROM FLOOR TO DECK ABOVE.
 - CEMENT PLASTER. REFER TO SHEET AS911.
 - SUSPENDED GYPSUM WALLBOARD CEILING. REFER TO SHEET AS911.
 - SUSPENDED T-BAR ACOUSTICAL CEILING WITH 2'-0" x 2'-0" INFILL PANELS. REFER TO SHEET AS911.
 - CONCRETE FLOOR ABOVE. REFER TO STRUCTURAL DRAWINGS.
 - LIGHT FIXTURES. REFER TO ELECTRICAL DRAWINGS FOR FIXTURE TYPES.
 - HVAC DIFFUSERS. REFER TO MECHANICAL DRAWINGS FOR DIFFUSER TYPES.
 - LINEAR DIFFUSER. TITUS FLOWBAR OR EQUAL. REFER TO MECHANICAL.
 - FIRE SPRINKLER HEAD LOCATION AT AUDITORIUM. REFER TO FIRE PROTECTION DRAWINGS FOR SPRINKLER HEAD LOCATIONS THROUGHOUT REMAINDER OF BUILDING.
 - CEILING ACCESS PANEL. ALSO INDICATES DIRECTION OF DOOR SWING. SEE DETAIL 6/AS911.
 - EXIT SIGN. SOLID LINES INDICATES THE LOCATIONS OF ILLUMINATION WITH EXIT DIRECTIONAL ARROW. REFER TO ELECTRICAL DRAWINGS FOR FIXTURE TYPES.
 - (E) SUSPENDED GYP. WALL BOARD CEILING TO REMAIN. PAINT.

- REFLECTED CEILING PLAN - REMODEL KEYNOTES**
- EXISTING SKYLIGHT AND SLOPING CEMENT PLASTER SOFFIT TO REMAIN. TYPICAL OF 7., PAINT CEMENT PLASTER.
 - (E) SUNSCREEN TO REMAIN, U.N.O. REMOVE DEBRIS AND CLEAN VIA POWER WASH.
 - DECORATIVE PANEL CEILING. (OMIT DECORATIVE PANEL CEILING AT DEDUCTIVE ALTERNATE 4)
 - (E) CEILING HVAC DIFFUSERS, LIGHTING & ELECTRICAL DEVICES TO REMAIN, TYP.
 - CEMENT PLASTER SOFFIT PAINT
 - (E) CEMENT PLASTER TRELIS, PAINT
 - (E) GYPSUM BOARD CEILING, PAINT.
 - PROJECTOR MOUNT. SEE ELECTRICAL DRAWINGS.

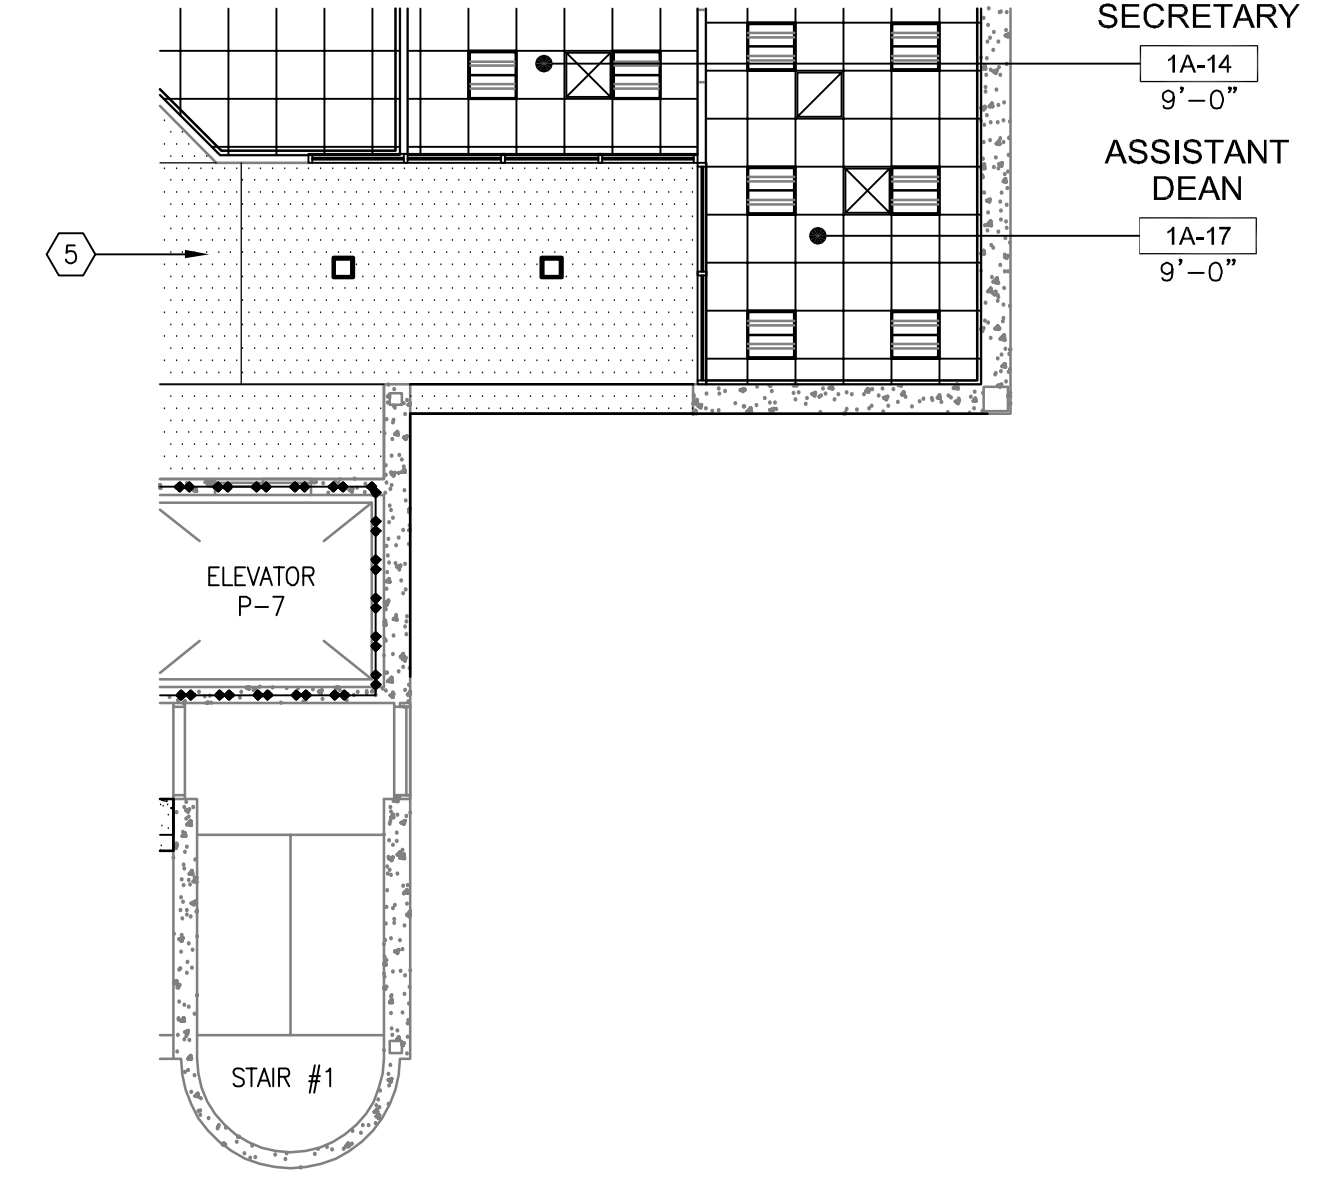

REMODELED PARTIAL FIRST FLOOR REFLECTED CEILING PLAN
DEDUCTIVE ALTERNATE 1
1/8" = 1'-0"

CONSULTANTS:		ARCHITECT/ENGINEERS:		Drawing Title FIRST FLOOR REFLECTED CEILING PLAN		Project Title BUILDING 24 SEISMIC CORRECTION AND ADDITION		Project Number 570-215		Office of Construction and Facilities Management Department of Veterans Affairs	
				Approved Project Director		Location VAMC FRESNO, CA		Building Number 24			
						Date March 12, 2013		Checked BB			
Revisions								Drawn CLO		Drawing Number AS301	
										Dwg. 56 of 180	